



PLAN - PILE CAP TYPICAL PRECAST PIER
SCALE 1:50

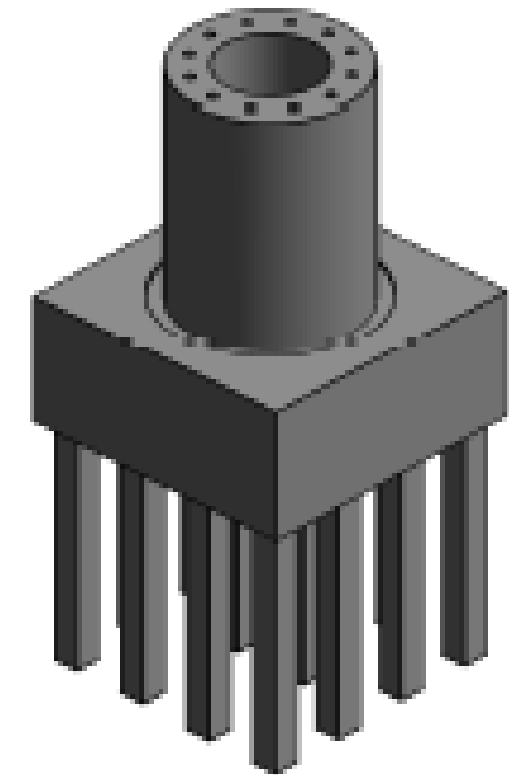


3D VIEW PILECAP OF PRECAST PIER

PILE CAP SCHEDULE

PILE CAP	DEPTH 'H'	LENGTH 'L'	WIDTH 'B'	RL TOP OF PILE CAP	RL BOTTOM OF PILE CAP
01/P/01/01/01	2000	1.500	0.500	0.000	-1.000
01/P/01/01/02	2000	1.100	0.500	0.000	-1.000
01/P/01/01/03	2000	1.100	0.500	10.0	-0.900
02/P/01/01/01	2000	1.500	0.500	-0.000	-1.000
02/P/01/01/02	2000	1.100	0.500	0.000	-1.000
02/P/01/01/03	2000	1.100	0.500	10.00	-0.900

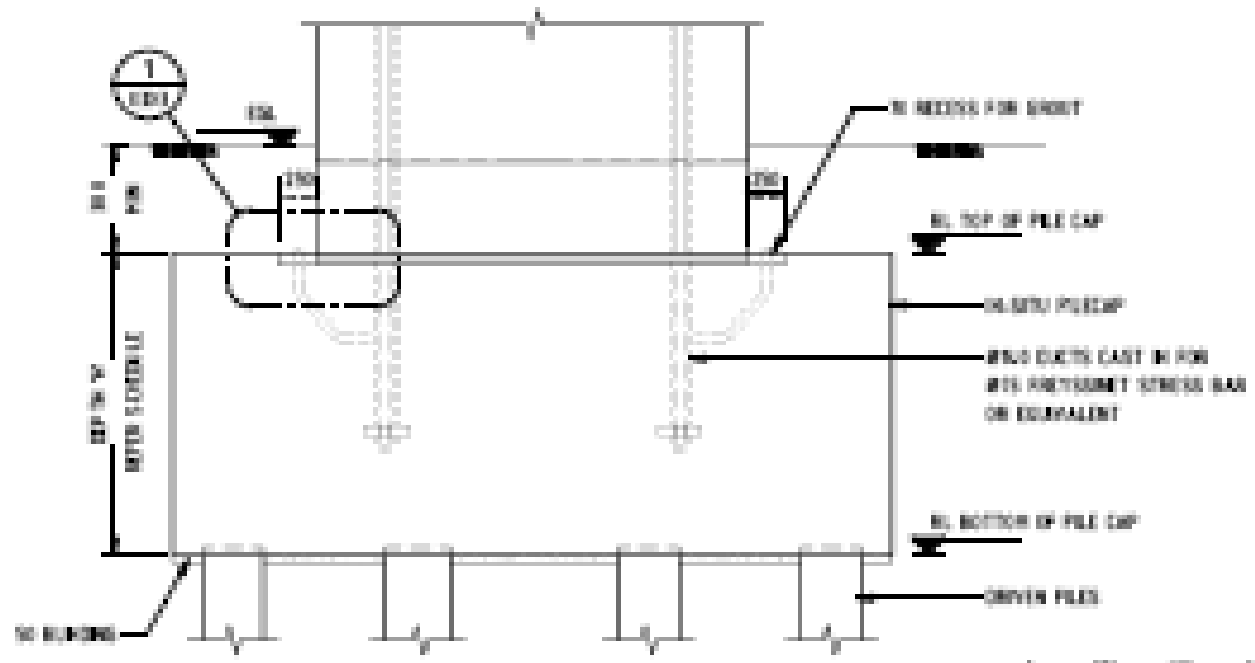

TYPICAL PILECAP ELEVATION
SCALE 1:50

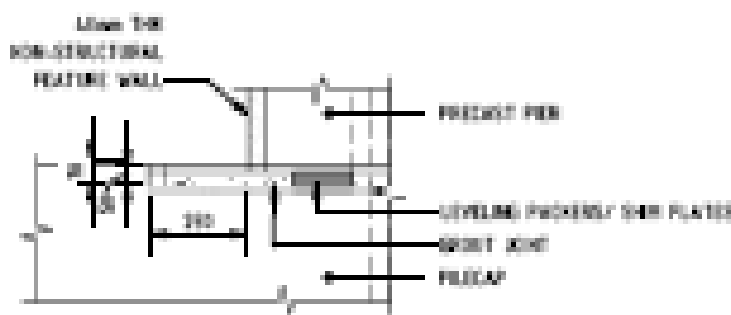

DETAIL 1
SCALE 1:20

NOTES
1. FOR GENERAL NOTES REFER DRAWING No. WGT-01-LR-01-AUT-000-001 TO 005.

FOR CONSTRUCTION

NO.	REVISION	DATE	BY	CHECKED

PROJECT TEAM

AJV CONSULTANTS

bureau JACOBS

PROJECT NO. 2000000
DRAWING NO. 000000

CLIENT

Transurban

WEST GATE TUNNEL PROJECT

WEST GATE TUNNEL PROJECT


4RD CITYLINKIVITY CONNECTION

DATE: 01/01/2020
SCALE: 1:50
SHEET NO. 1


BRIDGE 36 RAMP OVER HPC SUBSTRUCTURE

PILECAP DETAILS - CONCRETE


DATE: 01/01/2020
SCALE: 1:50
SHEET NO. 1

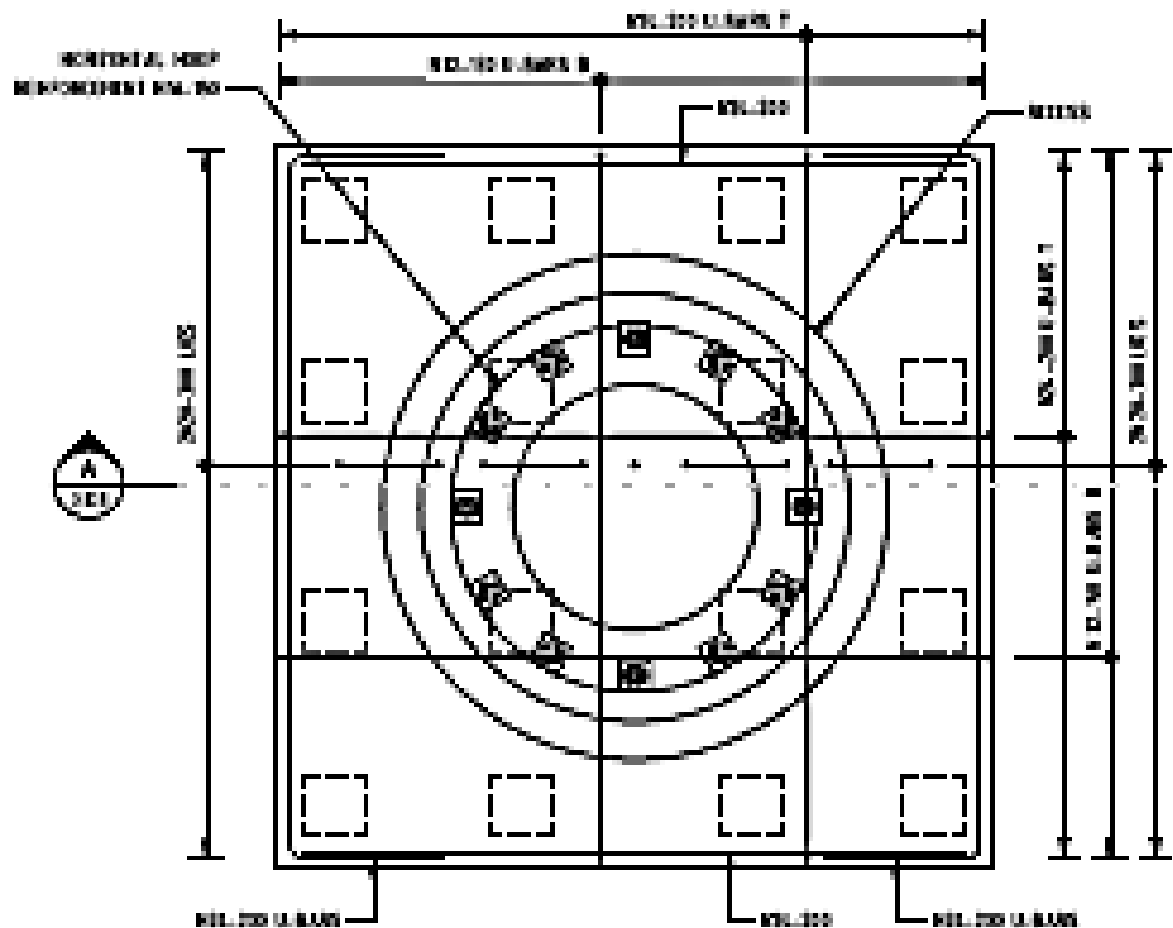


PILE CAP REINFORCEMENT PLAN - R1-R2 & R3-R4
SCALE 1:100

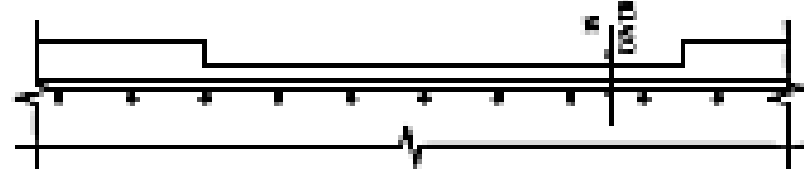


TOP REINFORCEMENT CROSS DETAIL ON PILECAP BECKET
SCALE 1:100

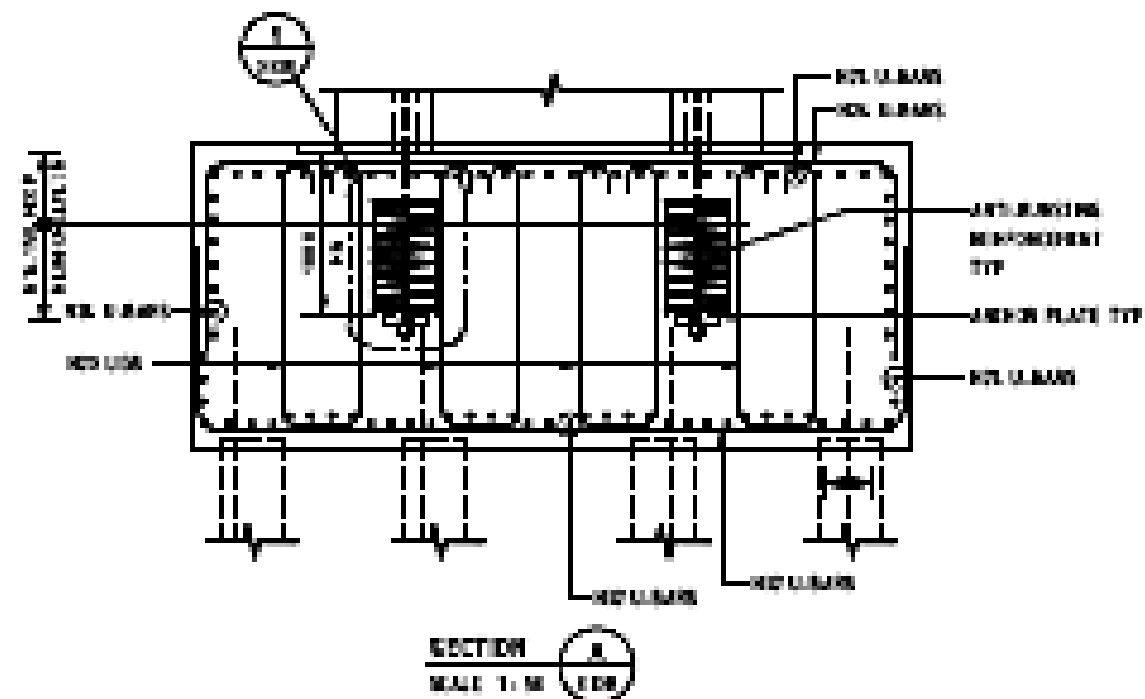

SECTION A-A
SCALE 1:100

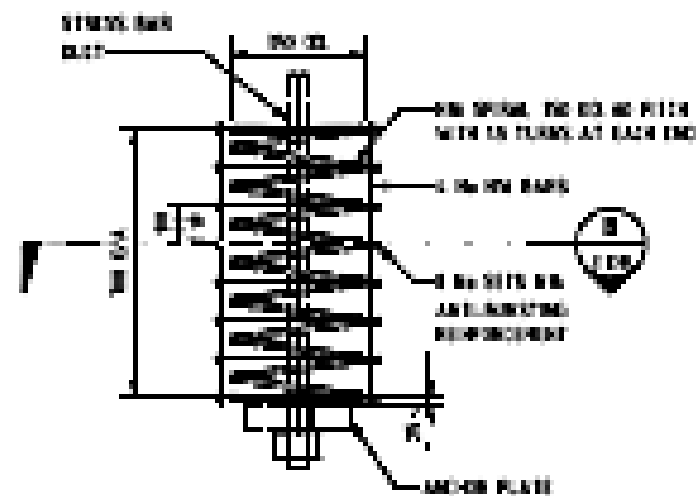

DETAIL I
SCALE 1:100

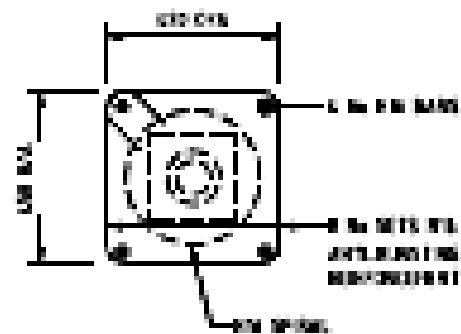


SECTION B-B
SCALE 1:100

TYPICAL ANTI-BLINDING REINFORCEMENT DETAIL (FOR ALL ANCHOR PLATES)

NOTES

- FOR GENERAL NOTES REFER DRAWING No. WEST-GATE-LR-DRG-LR-001/002/003 TO 007.

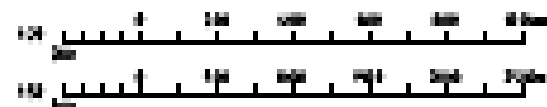

FOR CONSTRUCTION

NOT TO SCALE UNLESS OTHERWISE SPECIFIED

NO.	REVISION	DATE	BY	CHECKED

PROJECT: WEST-GATE-LR-DRG-LR-001/002/003 TO 007
CLIENT: TRANSCANTON
DESIGNER: BURECON JACOBS
DATE: 10/11/2017

TRANSCANTON
CONSTRUCTION
WEST-GATE

Transurban
WEST-GATE

WEST-GATE TUNNEL PROJECT			
AND CITY LINKIVITY CONNECTIONS			
NO.	DATE	BY	CHKD.
01	10/11/2017		
02			
03			

BRIDGE 14 RAMP 3/4/2 OVER MFC SUBSTRUCTURE
PILECAP DETAILS - REINFORCEMENT
SHEET 2
WEST-GATE-LR-DRG-LR-001/002/003 TO 007