
DETACHED ADU CONSTRUCTION <u>San Jose, California</u>

2 Bedroom

SITE PHOTO

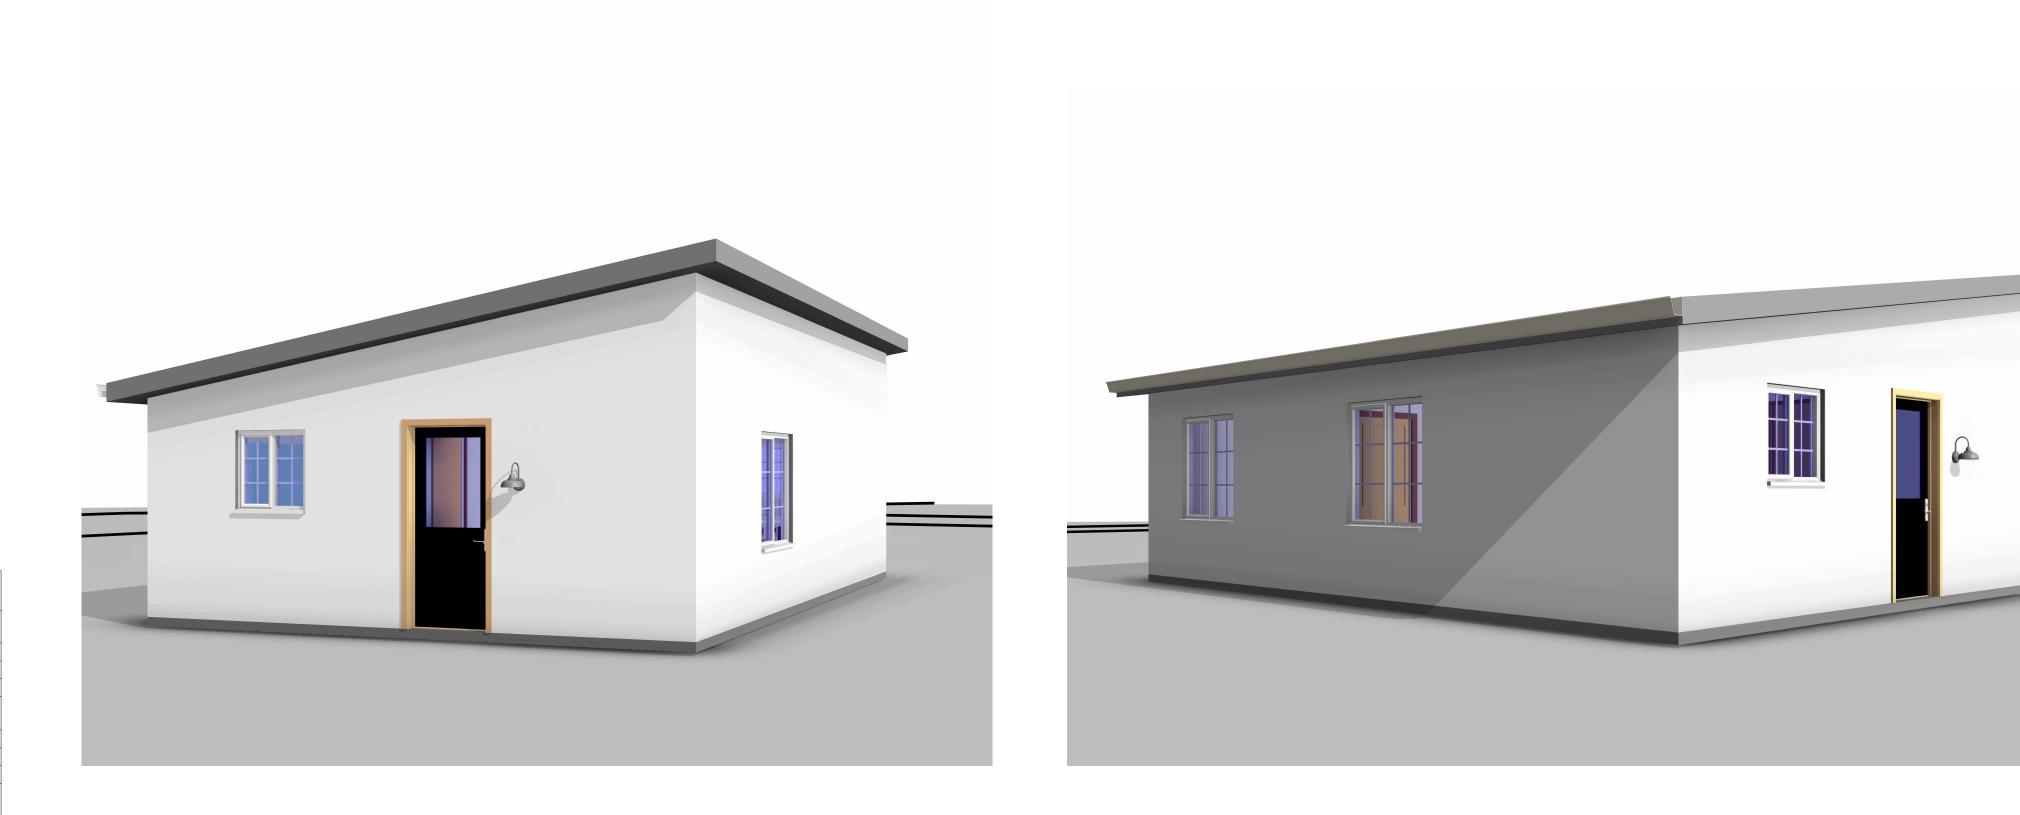

DRAWING INDEX

Sheet List

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PLAN	
	r
ELEVATIONS / SECTIONS	A2.0
ROOF PLAN & CROSS	A3.0
SECTIONS	

	ABBREVIATIONS												
AFF	ABOVE FINISHED FLOOR	CMU	CONCRETE MASONRY UNIT	EXT	EXTERIOR	GL	GLASS	LPT	LOW POINT	PRELIM	PRELIMINARY	TEL	TELEPHON
AFG	ABOVE FINISHED GRADE	CONSTR	CONSTRUCTION	FOC	FACE OF CONCRETE	GB	GRAB BAR	MFR	MANUFACTURER	PREP	PREPARATION	TV	TELEVISION
ACC	ACCESSIBLE	CD	CONTRACT DOCUMENTS	FO FIN	FACE OF FINISH	GMP	GUARANTEED MAXIMUM PRICE	MO	MASONRY OPENING	PL	PROPERTY LINE	TSTAT	THERMOST
ACT	ACOUSTICAL CEILING TILE	CTRL	CONTROL	FOM	FACE OF MASONRY	GYP	GYPSUM	MATL	MATERIAL	REC	RECESSED	THK	THICKNESS
ADJ	ADJACENT	CJ	CONTROL JOINT	FOS	FACE OF STUD	GYP BD	GYPSUM BOARD	MAX	MAXIMUM	RCP	REFLECTED CEILING PLAN	TOB	TOP OF BE/
ALT	ALTERNATE	CORR	CORRIDOR	FT	FEET	HC	HANDICAP	MECH	MECHANICAL	REF	REFRIGERATOR	TOC	TOP OF CC
ALUM	ALUMINUM	CNTR	COUNTER	FIN	FINISH	HNDRL	HANDRAIL	MTL	METAL	REINF	REINFORCE	TFF	TOP OF FIN
ADA	AMERICANS WITH DISABILITIES ACT	DEMO	DEMOLITION	FF	FINISH FLOOR	HDWR	HARDWARE	MLWK	MILLWORK	REQD	REQUIRED	to FDN	TOP OF FO
AB	ANCHOR BOLT	DET	DETAIL	FF EL	FINISH FLOOR ELEVATION	HVAC	HEATING, VENTILATING, AND AIR CONDITIONING	MIN	MINIMUM	RESIL	RESILIENT	TOT	TOP OF TRU
APPROX	APPROXIMATE	DIAG	DIAGONAL	FA	FIRE ALARM	HT	HEIGHT	MISC	MISCELLANEOUS	RF	RESILIENT FLOORING	TOW	TOP OF WA
ARCH	ARCHITECT	DIA	DIAMETER	FACP	FIRE ALARM CONTROL PANEL	HO	HOLD OPEN	MTD	MOUNTED	REV	revision	XFMR	transfor <i>i</i>
A/E	ARCHITECT/ENGINEER	DIM	DIMENSION	FE	FIRE EXTINGUISHER	HC	HOLLOW CORE	NA	NOT APPLICABLE	RH	RIGHT HAND	TYP	TYPICAL
AHJ	AUTHORITY HAVING JURISDICTION	DW	DISHWASHER	FEC	FIRE EXTINGUISHER CABINET	HM	HOLLOW METAL	NIC	NOT IN CONTRACT	RD	ROOF DRAIN	UL	UNDERWRI
AVG	AVERAGE	DIV	DIVISION	FHC	FIRE HOSE CABINET	HORIZ	HORIZONTAL	NTS	NOT TO SCALE	RTU	ROOF TOP UNIT	UNO	UNLESS NO
BOF	BOTTOM OF FOOTING	DOC	DOCUMENT	FR	FIRE RATING	HB	HOSE BIBB	OFF	OFFICE	RM	ROOM	VB	VAPOR BA
BLDG	BUILDING	DR OPNG	DOOR OPENING	FIXT	FIXTURE	IIC	IMPACT ISOLATION CLASS	OC	ON CENTER	RO	ROUGH OPENING	VIF	VERIFY IN F
САВ	CABINET	DBL	DOUBLE	FLR	FLOOR	INCL	INCLUDED	OPNG	OPENING	SCHED	SCHEDULE	VEST	VESTIBULE
CPT	CARPET	DH	DOUBLE HUNG (DOOR, WINDOW)	FD	FLOOR DRAIN	INSUL	INSULATION	OPP	OPPOSITE	SIM	SIMILAR	VCT	VINYL CON
CLG	CEILING	DN	DOWN	FLR FIN	FLOOR FINISH	INT	INTERIOR	OD	OUTSIDE DIAMETER	SD	SMOKE DETECTOR	VWC	VINYL WAL
CTR	CENTER	DS	DOWNSPOUT	FLUOR	FLUORESCENT	ID	INTERIOR DESIGN	PT	PAINT	SC	SOLID CORE	WC	WALL COV
CL	CENTER LINE	DWG	DRAWING	FC	FOOTCANDLE	JAN CLO	JANITOR CLOSET	PNL	PANEL	STC	sound transmission class	WC	WATER CLO
CT	CERAMIC TILE	EA	EACH	FTG	FOOTING	KD	KILN DRIED	PERIM	PERIMETER	SPEC	Specification	WP	WATERPRC
СО	CERTIFICATE OF OCCUPANCY	ELEC	ELECTRIC	FDTN	FOUNDATION	LAM	LAMINATE	PLAM	PLASTIC LAMINATE	SPKLR	SPRINKLER	WT	WEIGHT
СО	CLEANOUT	EL	ELEVATION	FURN	FURNITURE	LAV	LAVATORY	PLYWD	PLYWOOD	SS	STAINLESS STEEL	W/O	WITHOUT
CLR	CLEAR	EMER	EMERGENCY	FF&E	FURNITURE, FIXTURE, AND EQUIPMENT	LDR	LEADER	LBS	POUND	STD	STANDARD	WD	WOOD
CW	COLD WATER PIPING	ENGR	ENGINEER	GA	GAGE	LH	LEFT HAND	PSF	POUNDS PER SQUARE FOOT	STA	STATION		
CFMF	COLD-FORMED METAL FRAMING	EQUIP	EQUIPMENT	GALV	GALVANIZED	LT WT	LIGHTWEIGHT	PSI	POUNDS PER SQUARE INCH	STOR	STORAGE		
COL	COLUMN	EXIST	EXISTING	GALV STL	GALVANIZED STEEL	LIN	LINEAR	PREFAB	PREFABRICATE	STRUCT	STRUCTURAL		
CONC	CONCRETE	EJ	EXPANSION JOINT	GC	GENERAL CONTRACTOR	I F	LINEAR FEET (FOOT)	PREFIN	PREFINISH	SUSP	SUSPEND		

1 Full Bathroom

PROJECT INFO

Conversion of existing detached garage into ADU

BUILDING SQUARE FOOTAGE

First floor

Total: 686 sqft


Overall Total: 686 sqft

APPLICABLE BUILDING CODES

California Building Code, 2018 Edition California Residential Code, 2018 Edition California Fire Code, 2018 Edition California Plumbing Code, 2018 Edition California Mechanical Code, 2018 Edition California Fuel Gas Code, 2018 Edition National Electrical Code, 2017 Edition California Energy Conservation Code, 2015 Edition

NFPA 101 - Life Safety Code 2018 Edition with State Amendments (2020)


SYMBOLS LEGEND

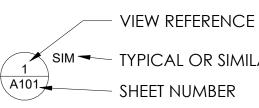

1 Ref /

SIM - TYPICAL OR SIMILAR - SHEET NUMBER

- INTERIOR ELEVATION

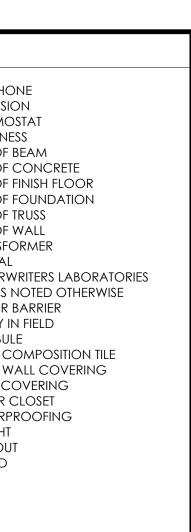

<u>ب</u>		- INTERIOR ELEVATION
َ ر	A101	- VIEW REFERENCE
	1 Ref	- SHEET NUMBER
⊐ Ref	1 Ref	- ELEVATION / SECTION CALLOUT - TYPICAL OR SIMILAR - VIEW REFERENCE
1	A101 1 1 Ref	- SHEET NUMBER
	101 -	- DOOR TAG
	(ji) -	- WINDOW TAG
	<u>_1</u> -	- REVISION
NAM	1E 🔿 🔫	- ELEVATION / LEVEL MARKER
	0	- DEMO NOTE
	? -	- KEYNOTE

ARCHITECTUR

NOTES:

1. All work shall conform to all state and applicable codes & ordinances.

2. No drawing is to be scaled; use dimensions only. 3. Dimensions are taken from face

of IFC, concrete or wood stud framing members unless otherwise indicated.

4. Confirm all existing conditions before proceeding with the said work.

5. Items not noted, but implied a necessary for th performance of the contract, are

considered part of the work. 6. All work is to be executed by nechanics skilled in their trade All trades will cooperate with each other to facilitate the progress if the entire job.

8. Contractor(s) is to protect the public and premises during the period of construction

with adequate shoring, bracing, fencing, lighting,ventilation, etc All changes or substitutions are to be approved by the owner

before being incorporated into the work. 10. Conform to all manufacturers instructions & specifications for the installation or use of all

materials unless otherwise noted.

DIVYANSHU ARORA

ADU Ζ **ONVERSIO** DETACHED

	COVER PAGE
	01.001
	D.A
	D.A
	A0.0
-	As indicated

<u>GENERAL</u>

1. WORK PERMORMED SHALL COMPLY WITH THE FOLLOWING: A.) THESE GENERAL NOTES, UNLSS OTHERWISE NOTED ON PLANS OR SPECIFICATION


B.) UNIFORM BUILDING CODE, APPLICABLE EDITION. C.) ALL APPLICABLE LOCAL AND STATE CODES, ORDINANCES AND REGULATIONS.

2. APPROVAL BY INSPECTOR DOES NOT MEAN APPROVAL OR FAILURE TO COMPLY WITH THE PLANS AND SPECIFICATIONS, ANY DESIGN WHICH FAILS TO BE CLEAR OR IS AMBIGUIOS, MUST BE REFERRED TO THE DESIGNER OR ENGINEER FOR INTERPRETATION OR CLARIFICATION.


3. THE DESIGN ADEQUACY AND SAFETY OR ERECTION BRACING, SHORING, TEMPORARY SUPPORTS, ETC IS THE SOLE RESPOMNSIBLITY OF THE CONTRACTOR AND HAS NOT BEEN COMSIDERED BY ENGINEER, THE CONTRACTOR IS RESPONSIBLE FOR STABILITY OF THE STRUCTURE PRIOR TO THE APPLICATION OF ALL SHEAR WALLS, ROOF AND FLOOR DIAPHRAMS, AND FINISH MATERIALS. HE SHALL PROVIDE THE NECESSARY BRACING TO PROVIDE STABILITY PRIOR TO THE APPLICATION OF THE AFOREMENTIONED MATERIALS.


44. CONTRACTOR SHALL INVISTIGATE SITE DURING CLEARING AND EARTHWORK OPERATIONS FOR FILLED EXCAVATIONS OR BURIED STRUCTURES SUCJ AS CESSPOOLS, CISTERNS, FOUNDATION, ETC. IF ANY, SUCH STRUCTURES ARE FOUND THE ENGINEER SHALL BE NOTIFIED IMMEDIATELY.

5. CONSTRUCTION MATERIAL SHALL BE SPREAD OUT IF PLACED ON FRAMED FLLORS AND ALL LOCAL, STATE AND FEDERAL CODES AND ORDINANACES. PROVIDE ADEQUATE SHORING AND/OR BRACING WHERE STRUCTURE HAS NOT ATTAINED DESIGN STRENGTH.

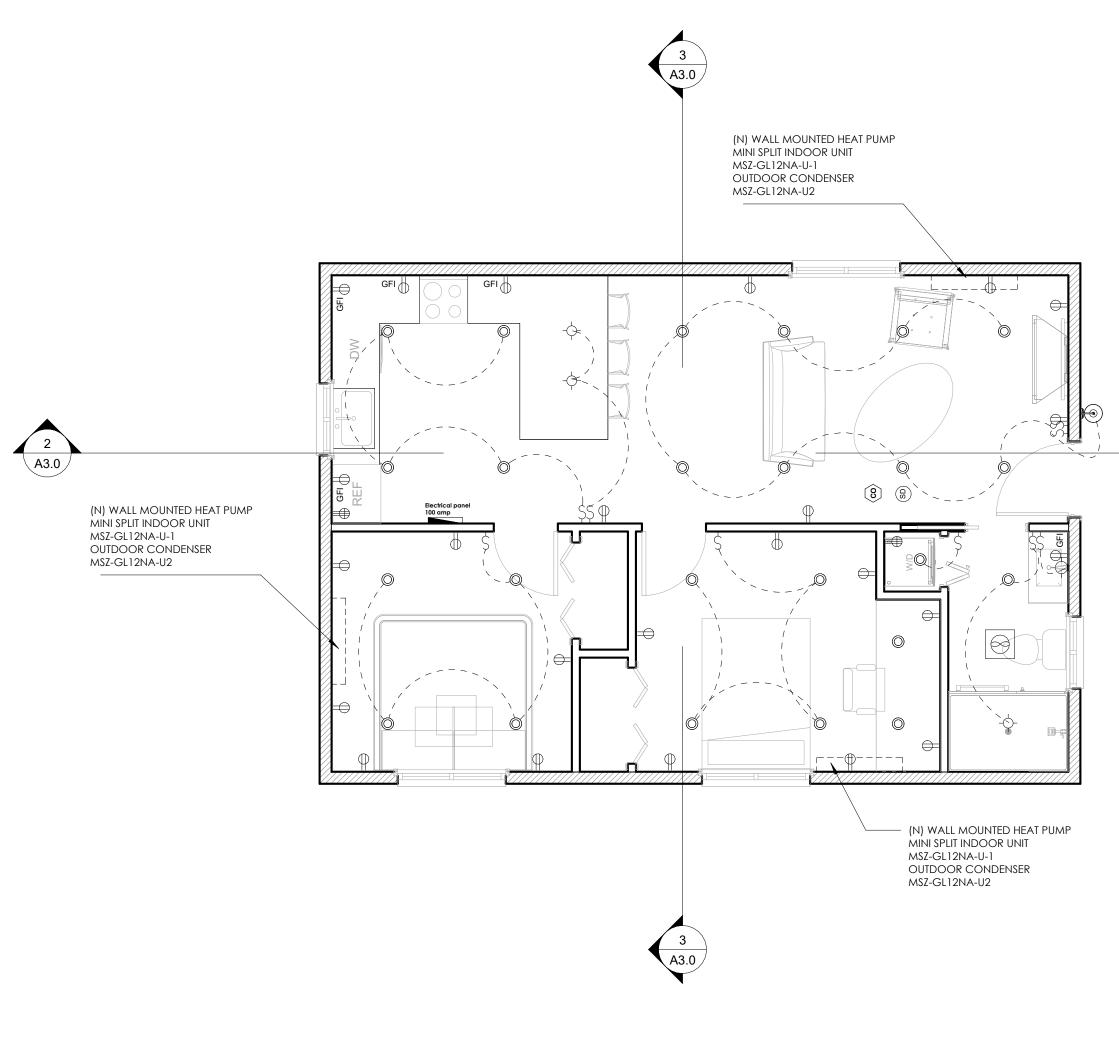

2 First Floor ELECTRICAL PLAN 1/4'' = 1'-0''

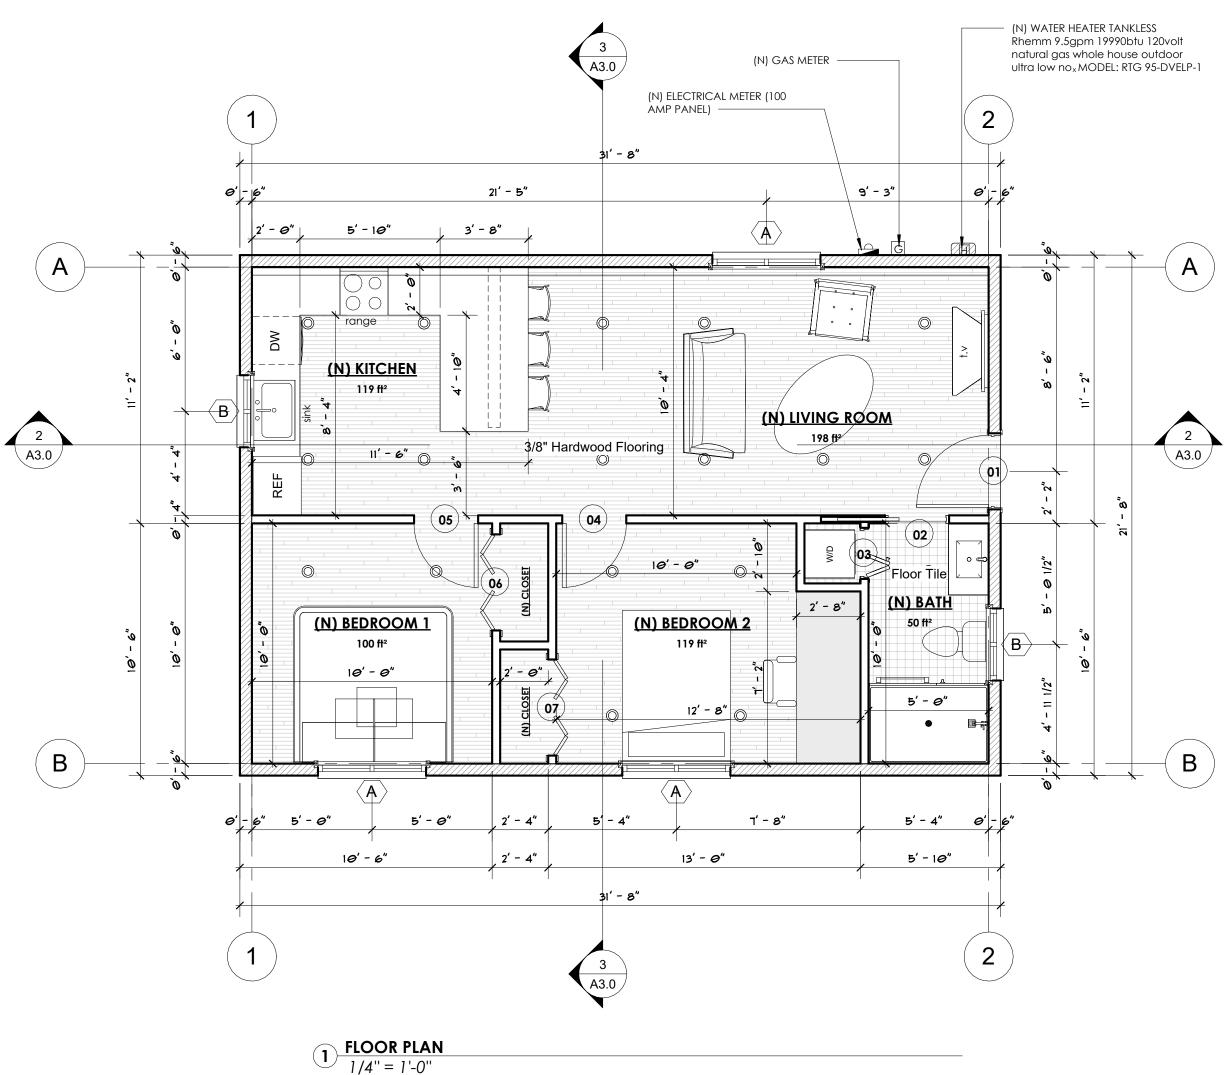

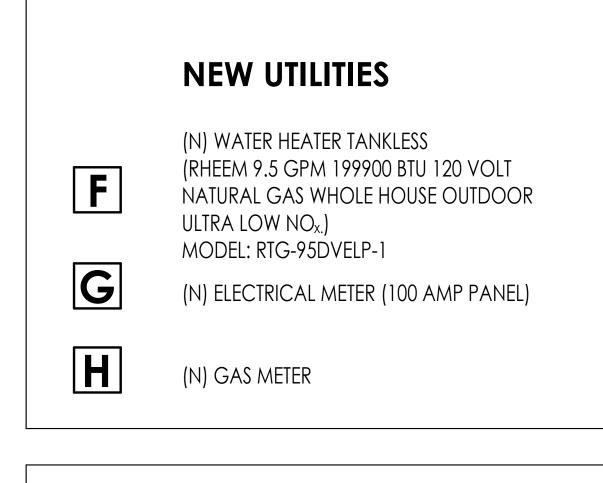

2 A3.0

ALL (R) GLAZING SHALL MEET THE FOLLOWING **REQUIREMENTS:** SHGC < 0.25 U-FACTOR < 0.32 (R) = (SAME SIZE AND OPERATION)(N) = (NEW SIZE AND OPERATION)THE NFRC TEMPORARY LABEL DISPLAYED ON WINDOWS MUST REMAIN ON THE UNIT UNTIL FINAL INSPECTION HAS BEEN COMPLETED

Room Schedule Level Name Area 100 ft² 119 ft² F.F (N) BEDROOM 1 (N) BEDROOM 2 F.F 50 ft² F.F (N) BATH 198 ft² (N) LIVING ROOM F.F F.F

119 ft² Grand total: 5

F.F

(N) KITCHEN

ARCHITECTURE

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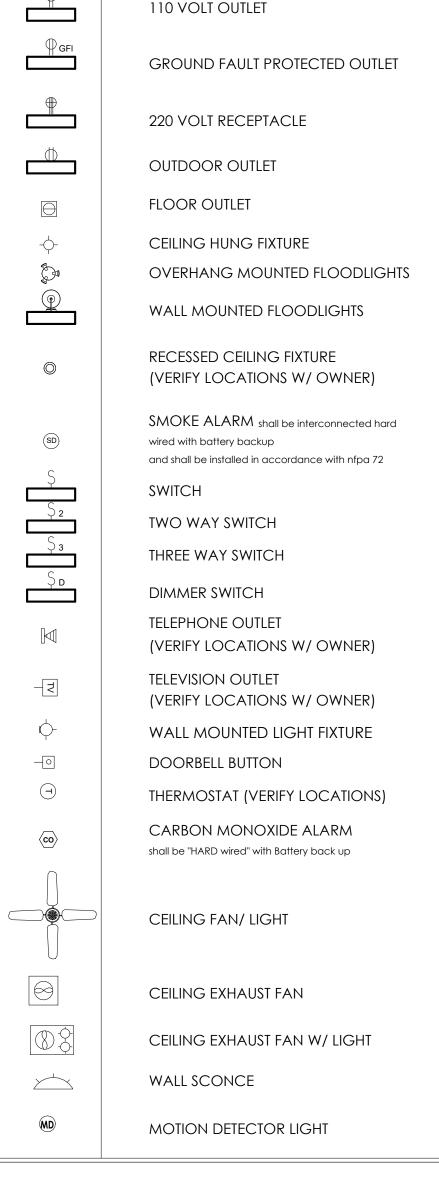
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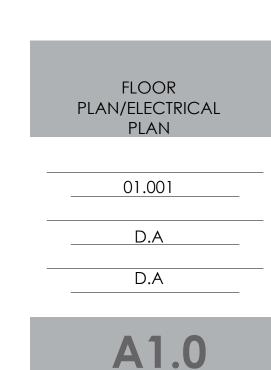
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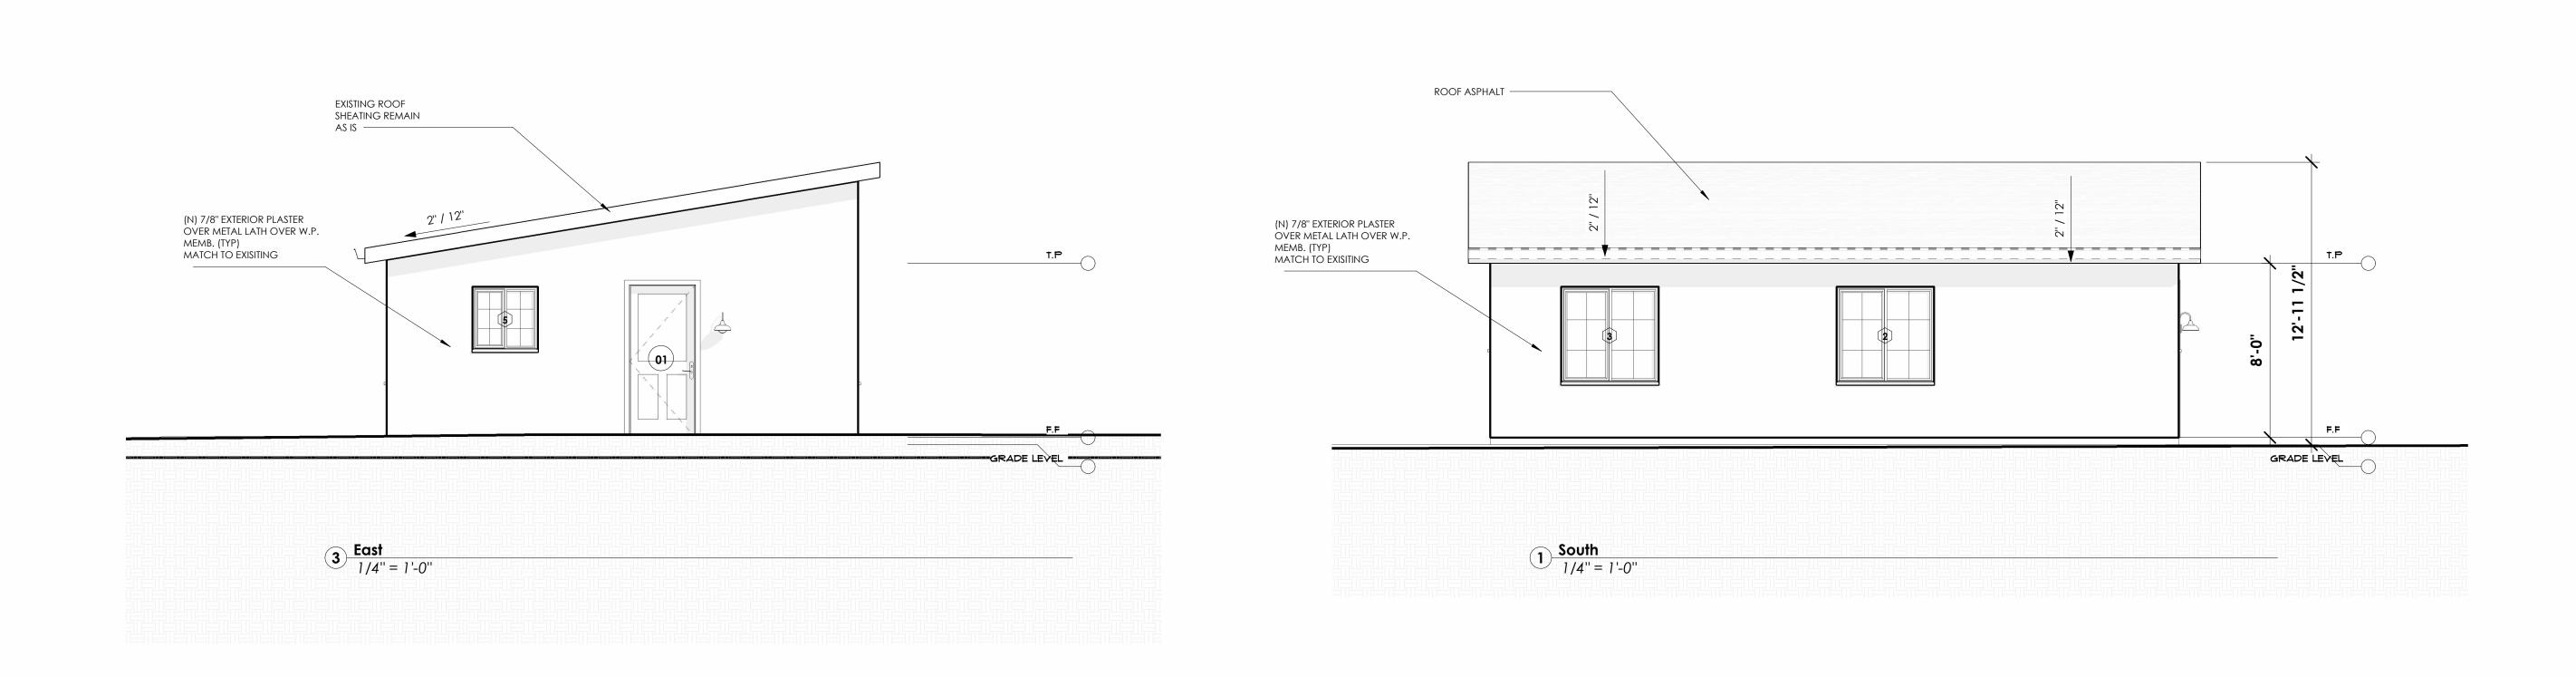
ELECTRICAL SYMBOLS LEGEND


110 VOLT OUTLET






1/4" = 1'-0"




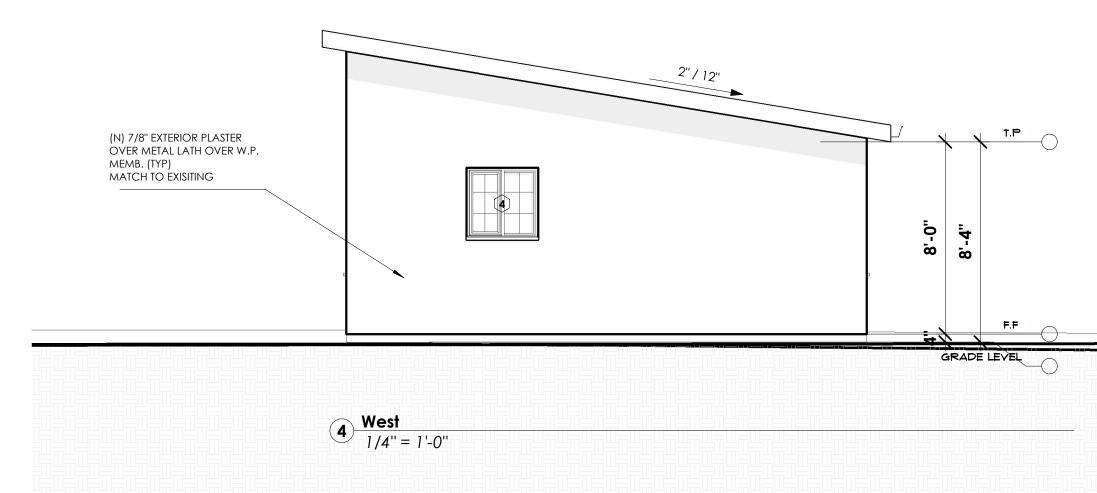

Window Schedule							
Mark	Level	Width	Height	Count			
1							
1	F.F	4' - 6''	4' - 6''	1			
2							
2	F.F	4' - 6''	4' - 6''	1			
3							
3	F.F	4' - 6''	4' - 6''	1			
4							
4	F.F	3' - 0''	3' - 0''	1			
5							
5	F.F	3' - 0''	3' - 0''	1			
Grand total: 5							

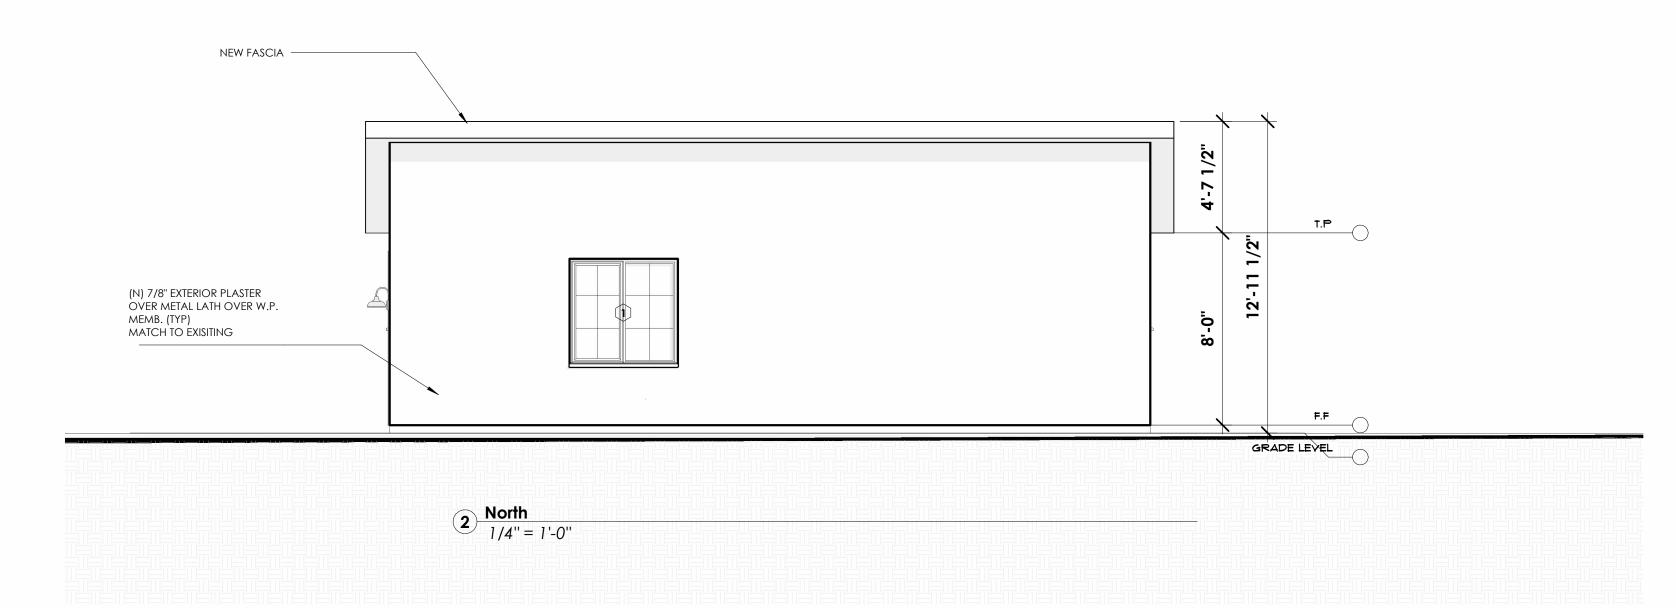

		D	oor Schedule	
Heigh	t Width	Count	Family	Family and 1
2_Panel_Bifo	ld_Door_18618			
7' - 0''	2' - 0''	1	2_Panel_Bifold_Door_18618	2_Panel_Bifold_Door_18 84''
Bifold - 4 Par	nel			1
6' - 8''	4' - 0''	2	Bifold - 4 Panel	Bifold - 4 Panel: 1525 x 2
Door-Exterio	r-Single-Entry-Half	Flat Glass-Wood	d_Clad	
7' - 0''	3' - 0''	1	Door-Exterior-Single-Entry-Half Flat Glass-Wood_Clad	Door-Exterior-Single-Entr Flat Glass-Wood_Clad:
M_Single-Flue	sh			· ·
6' - 8''	2' - 8''	2	M_Single-Flush	M_Single-Flush: 34" 4
Pocket_Slide	er_Door_5851			
7' - 0''	2' - 8''	1	Pocket_Slider_Door_5851	Pocket_Slider_Door_585 0.945
Grand total:	7		·	

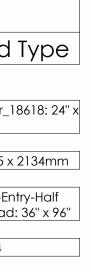

5851: 2.027 x



ARCHITECTURE

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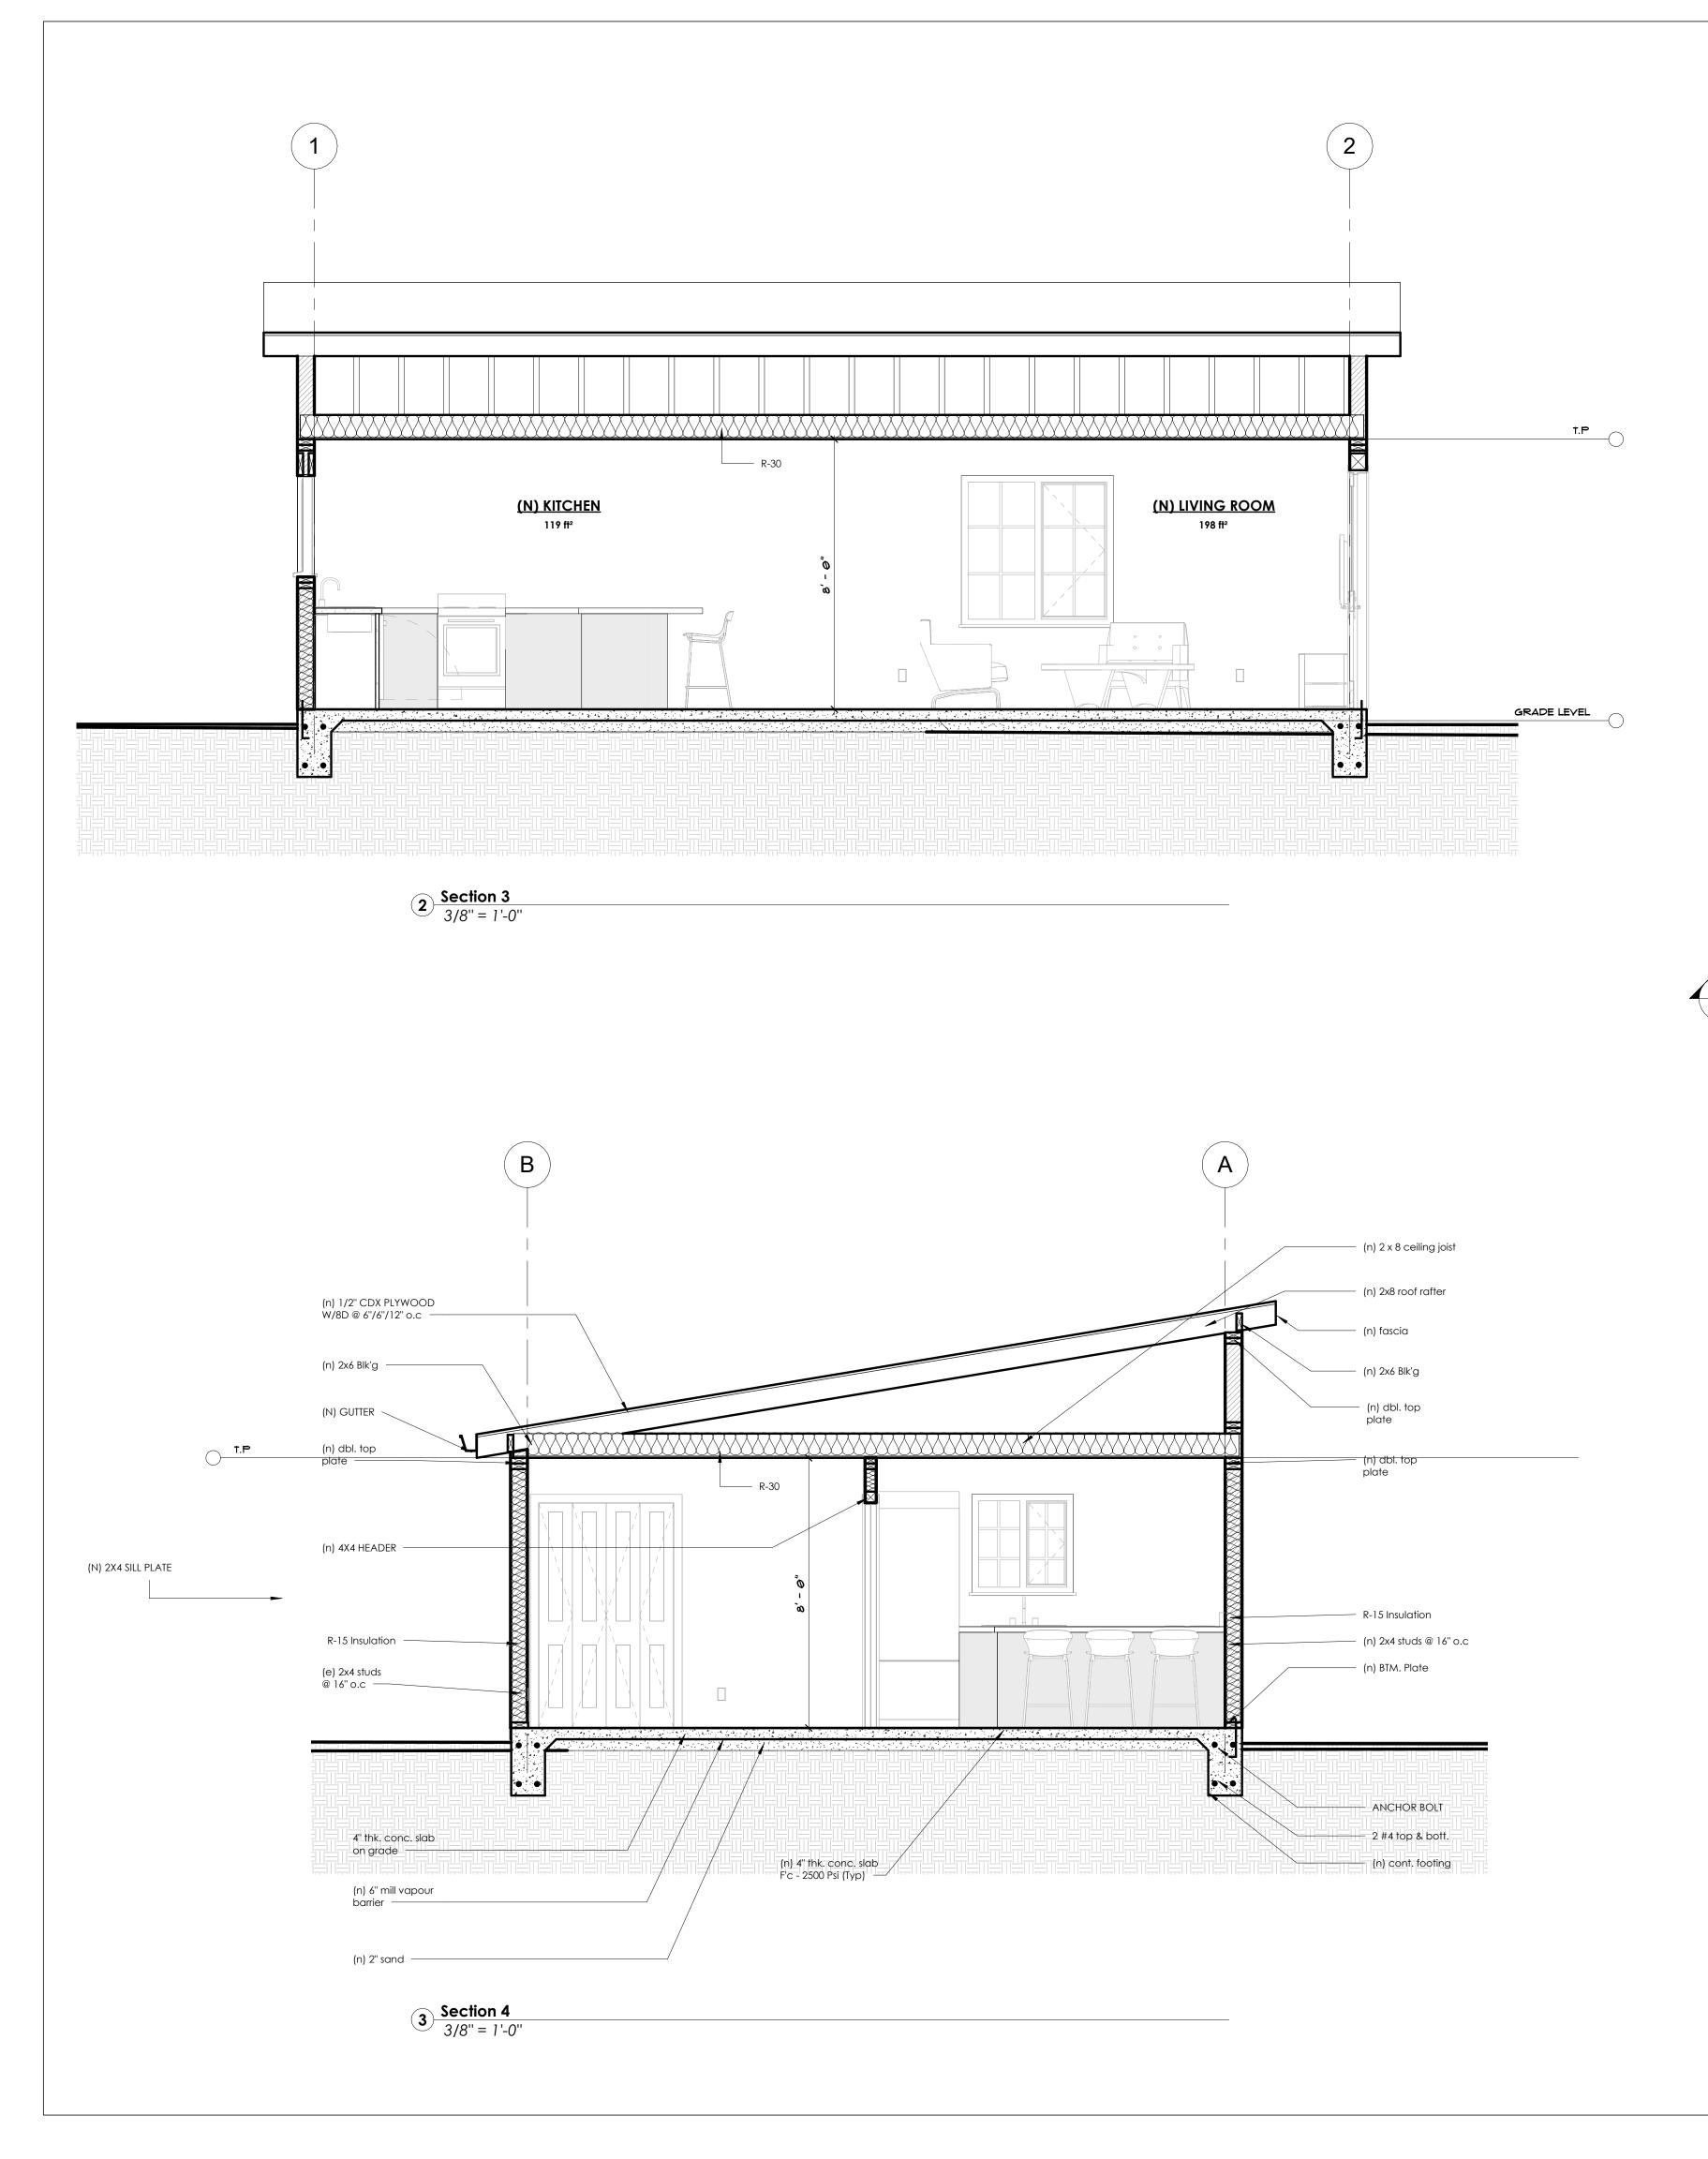
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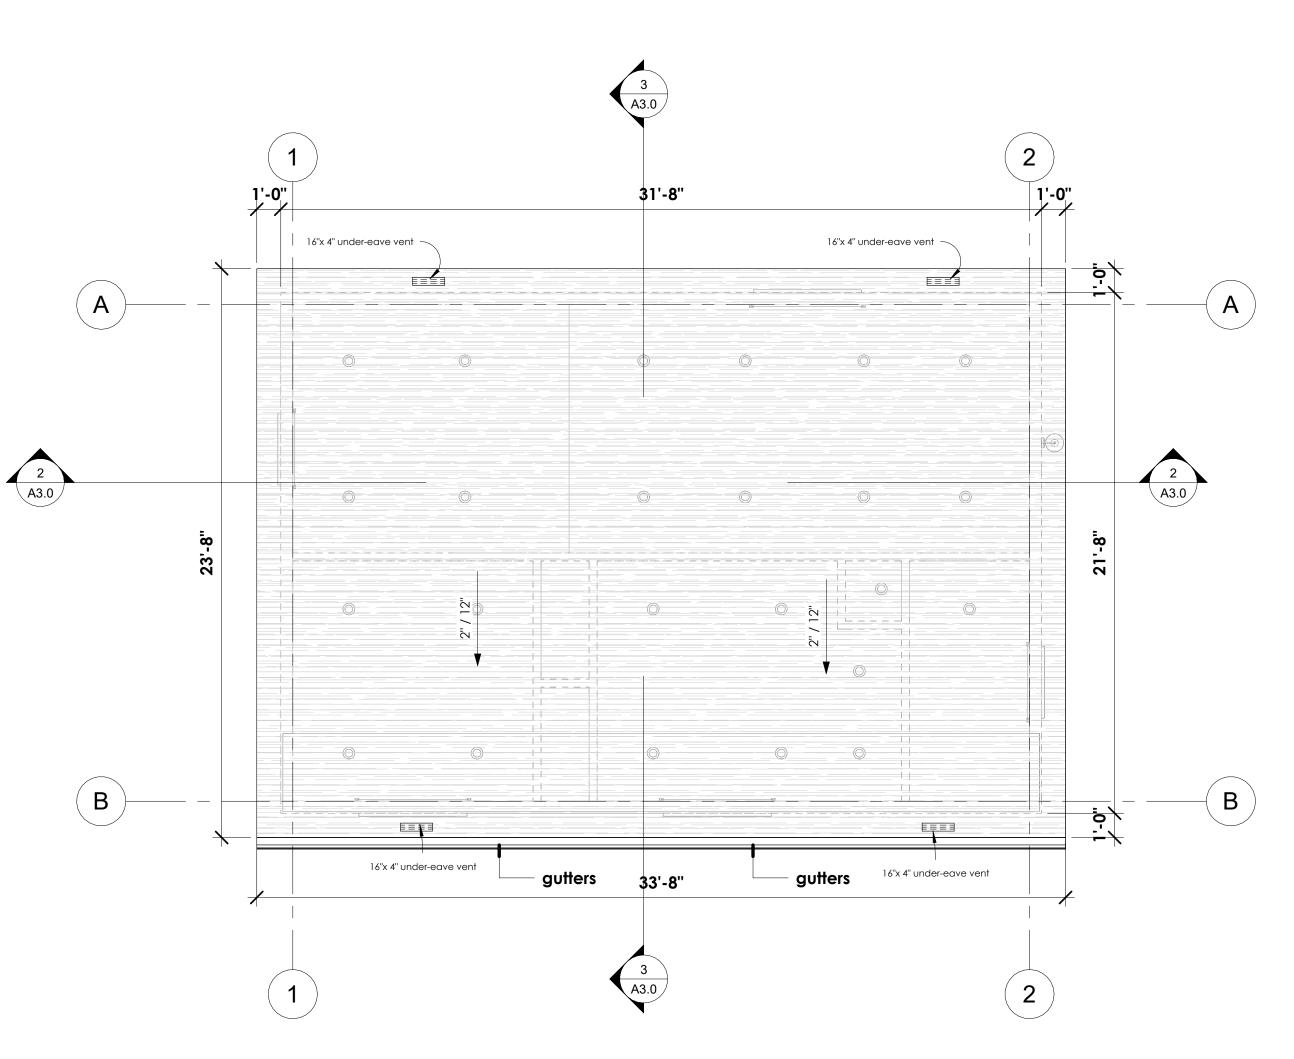
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DIVYANSHU ARORA

DETACHED ADU CONVERSION

ELEVATIONS / SECTIONS 01.001 D.A D.A A2.0 1/4" = 1'-0"





1 **ROOF PLAN** 1/4" = 1'-0"

ARCHITECTURE david.formarchitect@gmail.com

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DIVYANSHU ARORA

DETACHED ADU CONVERSION

ROOF PLAN & CROSS SECTIONS

01.001

DAVID FORM

DAVID FORM

